


Bob Thomas, NCARB btncarb@yahoo.com

30418 Briarcrest Dr. Georgetown, TX 78628 512-635-0621

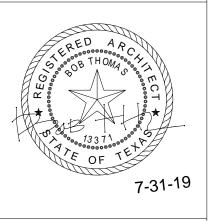

## BUILDING 200 E. 8th St. Georgetown, TX

Permit Issue Date:
7-31Revisions
Io. Date Description

No.	Date	Description
1		
2		
3		
4		
File	:	WS-D
Sca	ıle:	3/16" = 1'-0
Ву:		SR


Date: 7-31-19

Sheet Name

AWNINGS PLAN


Sheet No.

A11

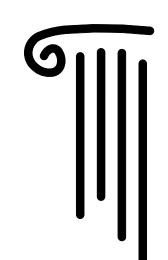

Bob Thomas, NCARB btncarb@yahoo.com

30418 Briarcrest Dr. Georgetown, TX 78628 512-635-0621

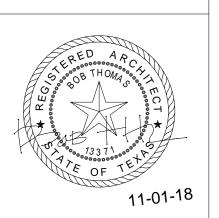

## BUILDING 200 E. 8th St. Georgetown, TX

Permit Issue Date: 11-01-18

No. Date Description

File: WS-DE
Scale: As indicated

Scale: As indicated


By: SRE

Date: 7-01-19

Sheet Name
CHURCH &
SOUTH
ELEVATIONS

Sheet No.

A2.1

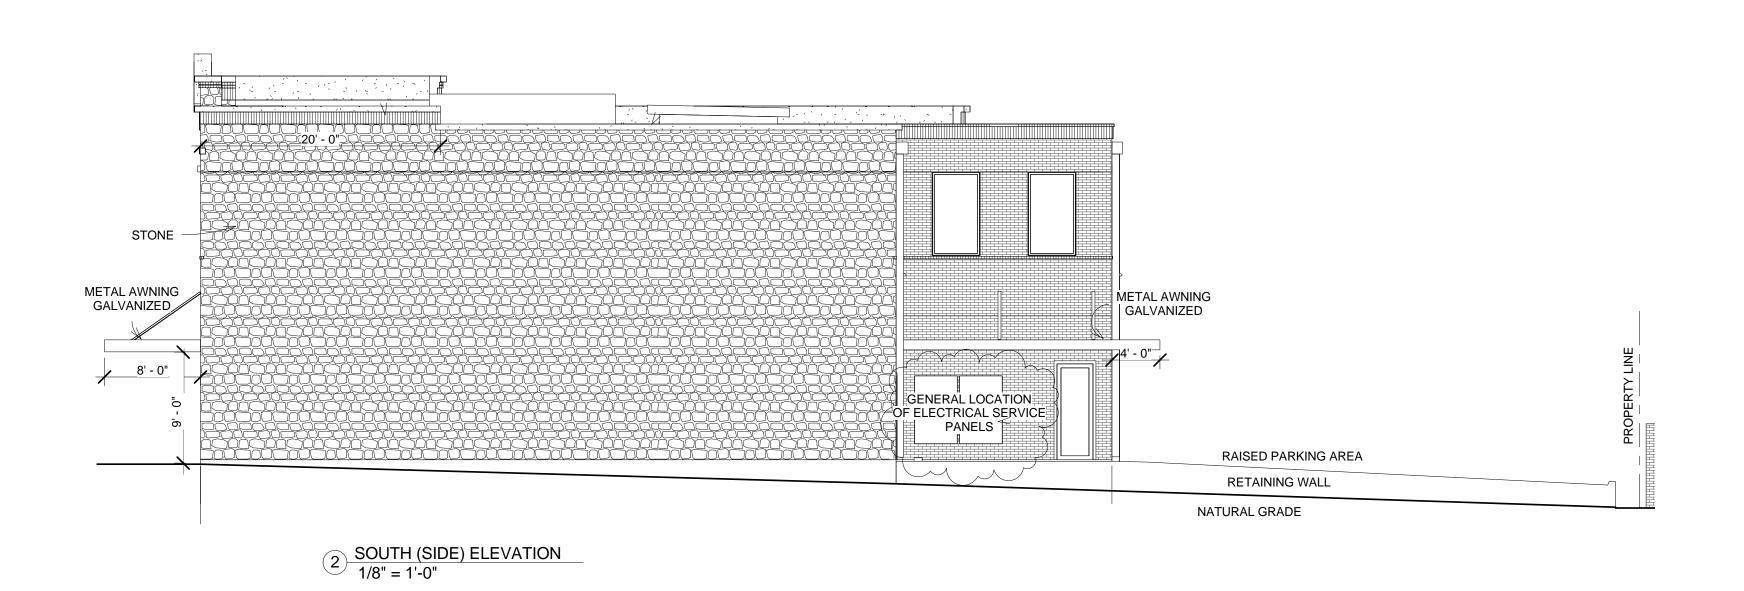



1 CHURCH St. (FRONT) ELEVATION 3/16" = 1'-0"

AWNING ENCROACHMENT NOTES:


A2.1.1 - AWNING ALONG 8TH ST. (LEFT SIDE ELEVATION) EXTENDS OVER SIDE PROPERTY LINE BY 8' - 0"

A2.1.2 - AWNING ALONG CHURCH ST. (FRONT ELEVATION) EXTENDS OVER FRONT PROPERTY LINE BY 8' - 0"

		HORIZON	ITAL ART	ICULATION CALCULATIONS FOR FOOTPRINT - (	CHURCH	ST FACADE
Average Bldg. Ht.	33.3	ft. x 3	99.9	ft. max. distance w.o. perpendicular offset	120	ft. actual distance of longest wall
Average Bldg. Ht.	33.3	ft. x 25%	8.325	ft. min. ht. of perpendicular offset	9	ft. actual perpendicular offset
Average Bldg. Ht.	33.3	ft. x 75%	24.975	ft. min. span of perpendicular offset	40	ft. actual span of perpendicular offset
		VERTICA	AL ARTICI	JLATION CALCULATIONS FOR ELEVATIONS - C	HURCH S	ST FACADE
Average Bldg. Ht.	33.3	ft. x 3	99.9	ft. max. distance w.o. vertical elevation change	120	ft. actual distance of longest wall
Average Bldg. Ht.	33.3	ft. x 25%	8.325	ft. min. ht. of vertical elevation change	10.5	ft. actual perpendicular offset
Average Bldg. Ht.	33.3	ft. x 75%	24.975	ft. min. lateral elevation change	40	ft. actual span of perpendicular offset

THE EXTERIOR DESIGN AND HEIGHT OF THE BUILDING APPROVED VIA COA-2018-029 BY THE HISTORICAL AND ARCHITECTURAL REVIEW COMMISSION ON JULY 24, 2018

E	XTERIOR FINISHES
NAME	DESCRIPTION
BRICK BRICK CORNICE STONE CORNICE/BANDING TRIM/METAL	REDLAND BRICK - TANGERINE SMOOTH MERIDIAN BRICK - ATHENS ARCH. V104 MERIDIAN BRICK - WHITE CHOP LIMESTONE AMERICAN ARTSTONE 78-05 GALVANIZED - POLISHED METAL

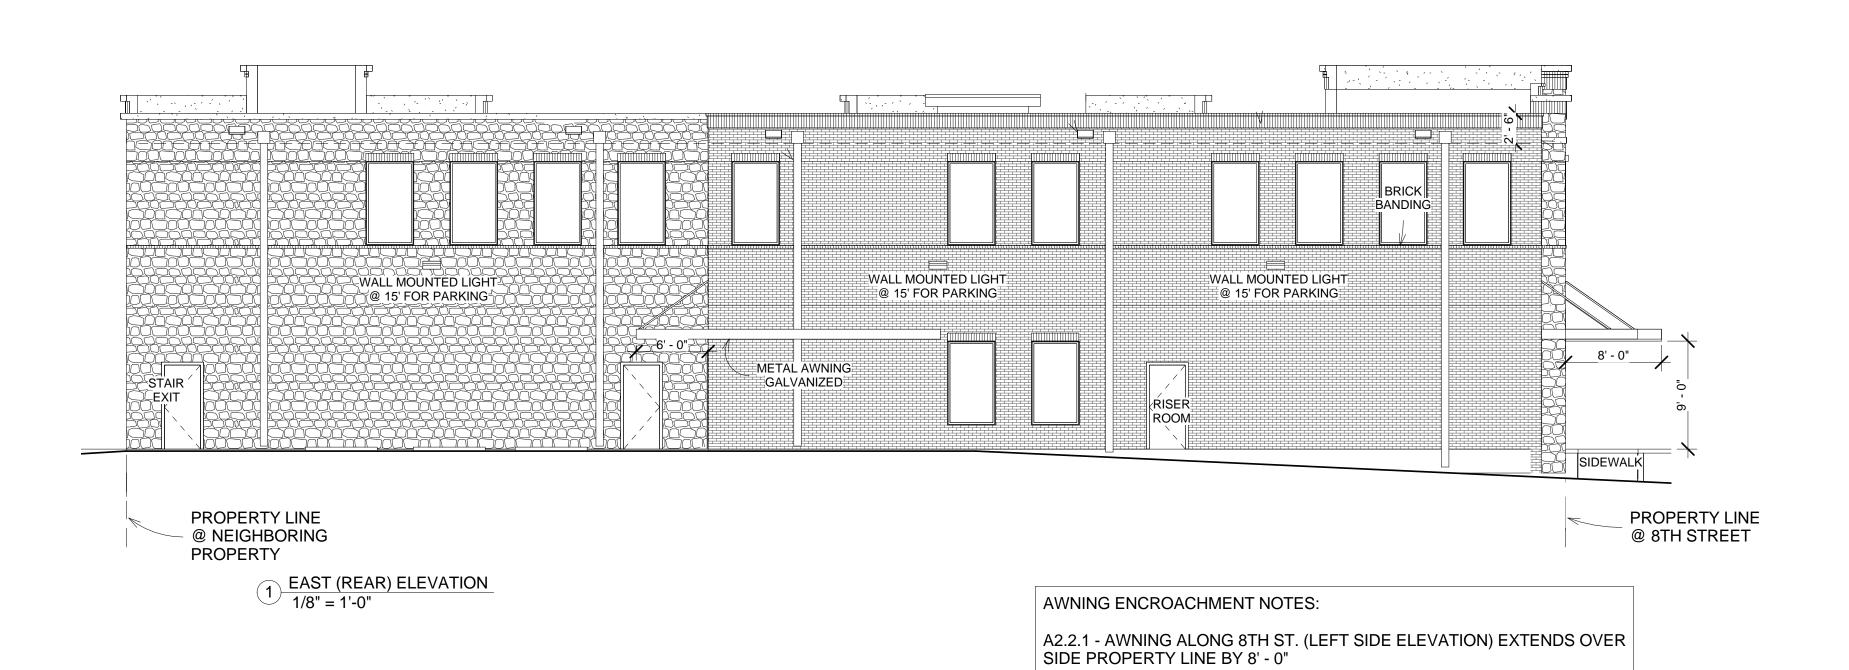


STONE

ST

A2.2.2 - AWNING ALONG CHURCH ST. (FRONT ELEVATION) EXTENDS


OVER FRONT PROPERTY LINE BY 8' - 0"

2 8th St. (SIDE) ELEVATION 3/16" = 1'-0"

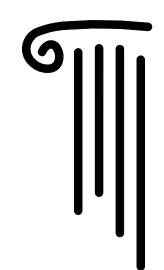

Bob Thomas, NCARB btncarb@yahoo.com

30418 Briarcrest Dr. Georgetown, TX 78628 512-635-0621

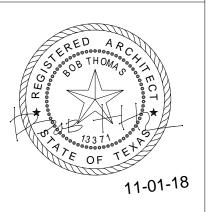

## BUILDING 200 E. 8th St. Georgetown, TX

Permit Issue Date: 11-01-18

Revisions

No. Date Description

No. Date Description

File: WS-DE
Scale: As indicated
By: SRE

Date: 7-01-19

Sheet Name
8TH & EAST

ELEVATIONS

Sheet No.

A2.2

ALL BUILDING SIGNAGE IS BEING APPLIED AND APPROVED SEPARATELY

THE EXTERIOR DESIGN AND HEIGHT OF THE BUILDING APPROVED VIA COA-2018-029 BY THE HISTORICAL AND ARCHITECTURAL REVIEW COMMISSION ON JULY 24, 2018

	EXTERIOR FINISHES
NAME	DESCRIPTION
BRICK BRICK CORNICE STONE CORNICE/BANDING TRIM/METAL	REDLAND BRICK - TANGERINE SMOOTH MERIDIAN BRICK - ATHENS ARCH. V104 MERIDIAN BRICK - WHITE CHOP LIMESTONE AMERICAN ARTSTONE 78-05 GALVANIZED - POLISHED METAL

						•
Average Bldg. Ht.	33.3	ft. x 3	99.9	ft. max. distance w.o. perpendicular offset	76	_ ft. actual distance of longest wall
Average Bldg. Ht.	33.3	ft. x 25%	8.325	ft. min. ht. of perpendicular offset	17.5	ft. actual perpendicular offset
Average Bldg. Ht.	33.3	ft. x 75%	24.975	ft. min. span of perpendicular offset	26	ft. actual span of perpendicular offset
		VEDT		ICULATION CALCULATIONS FOR ELEVATIONS -	0+h CT	
		VEKI	ICAL AKT	ICULATION CALCULATIONS FOR ELEVATIONS .	- 611131	FAÇADE
Average Bldg. Ht.	33.3	ft. x 3		ft. max. distance w.o. vertical elevation change	76	ft. actual distance of longest wall
Average Bldg. Ht. Average Bldg. Ht.			99.9			<b>,</b>