CONCEPTUAL SITE PLAN This conceptual plan does not represent the final site development plan and is subject to change. It is representative of the housing type, density, and general layout

SITE INFORMATION 1.46 ACRES. Parcel Identification Number R534492 Part of Block 4. Lots 5,6,7,&8 Part of Block 8, Lots 5,6,7, & 8 Part of W. 1st and 2nd St. & PartPart of Outlot I Division D, Town of Georgetown

ZONING: 203 FOREST STREET, GEORGETOWN, TX MU - DT MULTI FAMILY - DETACHED ZONED: PROPOSED USE:

MIN. ALLOWABLE LOT AREA: NO MINIMUM REQUIRED

63,561 SQ FT (1.46 ACRES) TOTAL LOT AREA:

SETBACKS: 0 FT FRONT YARD: STREET SIDE YARD:

INTERIOR SIDE YARD: REAR SIDE YARD:

MAX ALLOWABLE IMPERVIOUS COVERAGE: 70% MAXIMUM PER SEC 11.02.010.A.1.a PROPOSED IMPERVIOUS COVERAGE:

LOT SIZE IMPERVIOUS COVERAGE:

25,718 SQFT (40%) BUILDING 10,667 SQFT BUILDING PAVING / WALKS 15,051 SQFT PAVING / WALKS

PERVIOUS COVERAGE: 35,844 SQFT (60%) LANDSCAPE AREA: 35,844 SQFT LANDSCAPE AREA:

*IMPERVIOUS CALCULATIONS ARE APPROXIMATE AND DO NOT ACCOUNT HARDSCAPED AREAS YET TO BE DESIGNED

MAXIMUM ALLOWABLE BUILDING HEIGHT IN DOWNTOWN OVERLAY DISTRICT: MAXIMUM HEIGHT PER DEED RESTRICTIONS: 25' - 0"

MAXIMUM PROPOSED BUILDING HEIGHT:

REQUIRED PARKING SPACES:
MULTI-FAMILY PARKING REQUIREMENTS - PER SECTION 09.02.030

(25) 1-BEDROOM UNITS - 25 X 1.5 SPACES PER BEDROOM = 38 SPACES (1) 2-BEDROOM UNITS - 01 X 02 SPACES PER BEDROOM = 02 SPACES

40 SPACES + (40 SPACES *.05%) = 42 SPACES REQUIRED

*PROPOSED ALTERNATE PARKING PLAN PARKING REQUIREMENTS WILL BE MET THROUGH AN ALTERNATIVE PARKING PLAN THROUGH AN ADMINISTRATIVE

TREES
ALL EXISTING HERITAGE TREES TO BE PROTECTED AND REMAIN. TREE PRESERVATION AND PROTECTION REQUIREMENTS TO BE MET PER UDC SECTION 8.02

STORMWATER
TO BE COLLECTED IN CITY WATER DETENTION POND TO THE WEST

<u>LIGHTING</u>
ALL EXTERIOR LIGHTING TO COMPLY WITH UDC SECTION 7.04

SITE ZONING NOTES

SCALE: 1/4" = 1'-0"

<u>UNIT MATRIX</u>									
BUILDING TYPE	TYPE - I	TYPE - 2	TYPE - 3	TYPE - 4	TYPE - 5	TYPE - 6	TYPE - 7		
CONFIGURATION	TWO STORY STACKED STUDIO	TWO STORY TOWNHOME	TWO STORY STACKED FLATS	ONE STORY FLAT	TWO STORY STACKED FLATS	TWO STORY STACKED FLATS	TWO STORY TOWNHOME		
BUILDING HEIGHT	24'-1"	23'-8"	22'-4"	l 2'-8"	24'-9"	24'-9"	24'-2"		
NUMBER OF RENTABLE UNITS PER BUILDING	2	ı	2	ı	2	2	I		
BED / BATH	1/1	1/1.5	1/1	1/1	1/1	1/1	2/2.5		

UNIT AREA							
FIRST FLOOR	504 SF	384 SF	643 SF	643 SF	683 SF	683 SF	438 SF
SECOND FLOOR	504 SF	335 SF	643 SF	0 SF	720 SF	720 SF	869 SF
BUILDING AREA	1008 SF	719 SF	1286 SF	643 SF	1403 SF	1403 SF	1308 SF
PORCHES / UNCONDITIONED AREA	107 SF	96 SF	208 SF	94 SF	340 SF	404 SF	651 SF
BUILDING RENTABLE SF	1,115 SF	815 SF	1,494 SF	737 SF	1,743 SF	1,807 SF	1,958 SF

BUILDING COUNTS								
NORTHERN UNITS	3				4	l	1	
SOUNTERN UNITS		3	2	2				
PROJECT BUILDING COUNT								
UNIT COUNTS	6	3	4	2	8	2	1	
TOTAL NUMBER OF UNITS								

TOTAL RENTABLE SF	3,345 SF	2,445 SF	2,988 SF	1,474 SF	6,972 5F	1,807 SF	1,958 SF
PROJECT RENTABLE SF							20,989 SF





3RD S GEOF **REVISIONS** NO. DATE


PRELIMINARY

THESE DRAWINGS ARE FOR INTERIM REVIEW AND NOT FOR PERMITTING, OR CONSTRUCTION ANDREW BRAY 18754 04.05.19

Special Use Permit

BGB/AEB Drawn By: AEB Checked By: AEB Approved By: 1741 Project No. Original Issue Date:

SUP

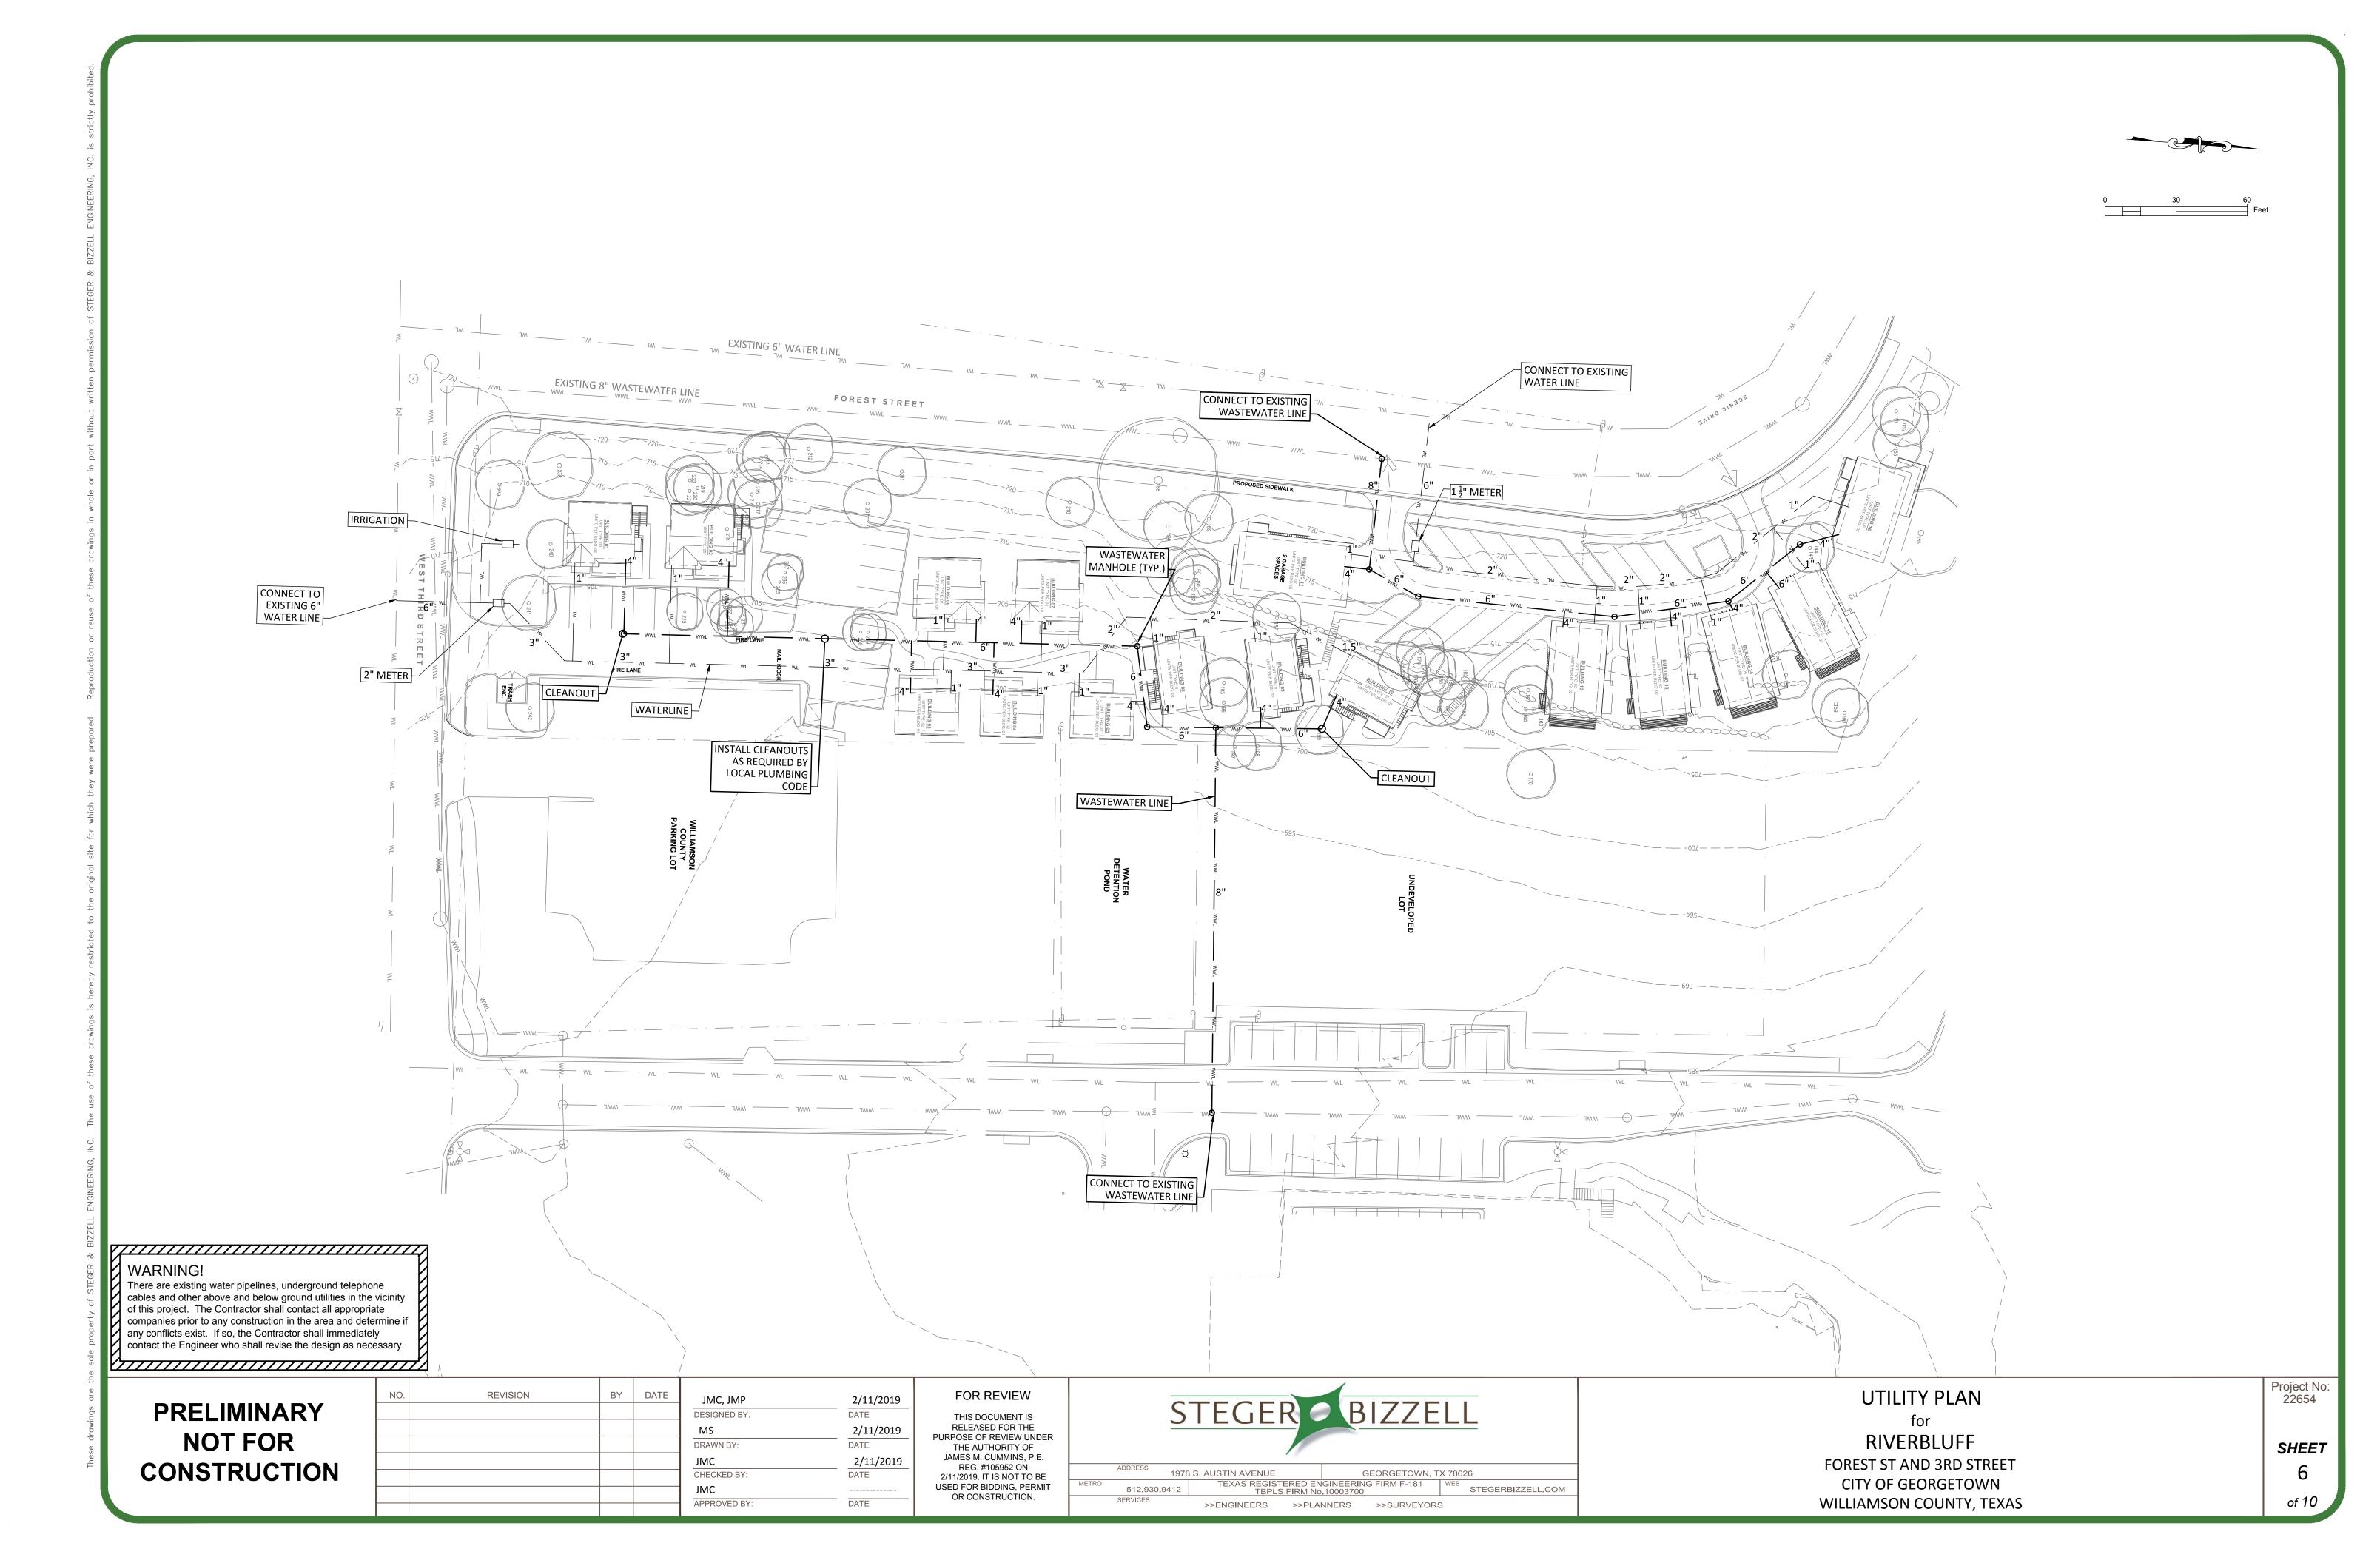

000-22999\22654 - River Bluff\CAD\Plans\UTILITY PLAN.dwg, 2/11/2019 4:00:49 PM, JIM, AutoCAD PDF (General Docun

	RVEY TAE		DESCRIPTION		O ₁₅₅
IST	PT. NO.	SIZE	DESCRIPTION	STREE VARO 0153	3 \\ \text{3.4529} \times \\ \tag{163.62}
1	143 144	8 " 6 "	ELM ELM	MARO ON SA	BUILDING 18 UNIT TYPE 06 UNITS PER BUGG 02
	145 146	7 " 8 "	ELM ELM	S S S S S S S S S S S S S S S S S S S	C160
	147 148	7 " 8 "	ELM ELM (5",5")		144 0 143
	149 150	4 " 5 "	ELM ELM		145 1 145 1 1 1 1 1 1 1 1 1 1 1 1 1 1 1
	151 152	4 " 8 "	ELM ELM		
	153 154	9 "	E.M E.M E.M(12", 8")	SC FAIL	BUILDING IS JUNIT TIPE OS UNITS PER BLOG 02
	155 156 157	18 " 3 " 6 "	ELM (12", 8") ELM ELM		LA1.01
	15 <i>7</i> 158 159	6 " 6 " 12 "	ELM (5",1",1") HACKBERRY (8",3",3",2")		LAI.UI
	160	6 " 8 "	ELM LIVE OAK	i '	SUILDING 13 UNIT TYPE: 05 UNITS PER BLDG: 02
	162 163	10 " 5 "	LIVE OAK LIVE OAK		30.16
	164 165	10 " 9 "	LIVE OAK LIVE OAK		GUY WIRE
	166 167	7 " 11 "	LIVE OAK LIVE OAK (7",7")	λ Ψ Ψ	OHE -
	168 169	16 " 9 "	LIVE OAK (8",7",4") LIVE OAK	当 ・ ・ ・ ・ ・ ・ ・ ・ ・ ・ ・ ・ ・	S S IDEWAL
	170 171	4 " 6 "	ELM ELM) He - 0	0170
	172 173	6 " 6 "	E.M E.M	- H	0113
	174 175	11 " 9 "	LIVE OAK	OHE -	
	176 177 178	5 " 16 "	LIVE OAK LIVE OAK (8",8",8") LIVE OAK	0.1	182 783
	178 179 180	3 " 9 " 4 "	LIVE OAK LIVE OAK LIVE OAK		180 185
	181 182	7 " 4 "	LIVE OAK LIVE OAK	HO H	
	183 184	9 " 8 "	ELM (6",5") LIVE OAK	— H	
	185 186	8 " 7 "	LIVE OAK LIVE OAK	HO I	
	187 188	11 " 25 "	ELM LIVE OAK	HO 1 1 1 1 1 1 1 1 1 1 1 1 1 1 1 1 1 1 1	0199
	189 190	6 " 8 "	ELM ELM	1 0 J	BUILDING 11 UNIT TYPE: 07 UNITS PER BLDG: 01
	191 192	7 " 7 "	ELM ELM	HO -	UNITS PER BLDG: 01 2 GARAGE SPACES S
	193 194	6 " 6 "	ELM ELM	ー 出 つ ー 当	198 Sept 198
	195 196	5 " 6 "	ELM ELM		195 0196
	197 198 199	9 " 6 " 6 "	ELM (5",6") ELM ELM	H S S S S	189 190 191 192
	199 200 201	7 " 7 "	ELM ELM LIVE OAK		BUILDING 08 UNIT TYPE 01 UNIT PER BLIDG: 02 UNITS PER BLIDG: 02
	202 203	7 " 11 "	ELM ELM(9",3")	OHE .	168
	204 205 206	8 " 5 " 7 "	且M 且M 且M(5",3")	THE WY	
	207 208	5 " 6 "	EM EM	N S S S S S S S S S S S S S S S S S S S	BUILDING 05 UNIT TYPE 02 UNITS PER BLDG: 01
	209 210	12 " 5 "	ELM (6",4",4",3") ELM	W N	9210
	211 212 213	7 " 7 " 8 "	ELM ELM ELM	E - OHB	BUILDING 07 UNIT TYPE: 04 UNITS PER BLDG: 01
	214 215	6 " 8 "	ELM LIVEOAK	HO W	BUILDING 04 UNIT TYPE: 02
	216 217 218	5 " 6 " 6 "	LIVE OAK LIVE OAK LIVE OAK	# H	UNIT TYPE 02 UNITS PER BLOG: 01
	219 220	9 " 9 "	LIVE OAK LIVE OAK	0 - 3 - W - N - S - N - N	203
_	221 222	12 " 12 "	LIVE OAK LIVE OAK	OHE - 0	BUILDING 06 UNIT TYPE: 04 UNITS PER BLDG: 01
	223 224 225	6 " 8 " 7 "	LIVE OAK LIVE OAK ELM		BUILDING 03 UNIT TYPE 02 UNITS PER BLDG: 01
	226 227	5 " 4 "	LIVE OAK LIVE OAK	S T R E	9211
	228 229 230	4 " 5 " 5 "	LIVE OAK LIVE OAK LIVE OAK		209 209 208
	231 232	4 " 4 "	LIVE OAK ELM	FO RE	
	233 234 235	4 " 5 " 6 "	ELM ELM ELM		212 205 206
	236 237	7 " 5 "	ELM ELM		257, 236 235 MAIL KIOSK
	238 239	14 " 10 "	CHINABERRY ELM (7",5")	- W S	213 2214 215 2214 216 2214
	240 241 242	10 " 12 " 12 "	ELM ELM (7",5",4") ELM		0 216 207 227 208
					BUILDING 02 UNITTYPE PER BLDG: 02 UNITTY PER BLDG: 02
	NARCH TREE TECTED/ SAVE	0			222 0 220 0 225 0 225 0 225 0 225 0 225 0 225
	OVAL OF PRO	ECTED TREE TH & DISEASE			LA1.03
101	I PROTECTED T I PROTECTED, (I PROTECTED S			W. S-201	
اد	NOTEUTED S				STREET XARD UNIT TYPE: 03 UNITS PER BLUG: 02 H
<i>,</i> -	R OF PROTEC	IED TDEES: 40			UNITS PER BLOG 02
TED T	REE PRESERVA		TION (UDC SECTION 8.02.030.E.2)		STREETYARD 5
		al Acreage = Tre al # of Protected	e Density Trees Required to Remain on Site***		0241
	R OF PROTEC		IRED TO REMAIN: 5		05 TR SH ENC.
ates	per UDC Sectio	n 8.02.020:		OHE — OHE — OHE — OHE — OHE — OHE	S 89 12 46 W 136-68' S 89 12 46 W 136-68'
ı	ected Trees to I	e removed (repl.	rate 1:1 for 40%) 0* *no mitigation	uired since	STILL STILL STILL OHE OHE

*** Any fraction of a tree equals a full tree

COG LANDSCAPE PLAN NOTES

- THE CONVENTIONAL SYSTEM FOR IRRIGATION HAS BEEN SELECTED FOR THIS DEVELOPMENT.
- CONVENTIONAL SYSTEM: AN AUTOMATIC OR MANUAL UNDERGROUND IRRIGATION SYSTEM, WHICH MAY HAVE CONVENTIONAL SPRAY OR BUBBLER TYPE HEADS.
- 2. A SEPARATE IRRIGATION PLAN SHALL BE PROVIDED AT THE TIME OF APPLICATION FOR A BUILDING PERMIT.
- MAINTENANCE: THE CURRENT OWNER AND SUBSEQUENT OWNERS OF THE LANDSCAPED PROPERTY, OR THE MANAGER OR AGENT OF THE OWNER, SHALL BE RESPONSIBLE FOR THE MAINTENANCE OF ALL LANDSCAPED AREAS AND MATERIALS, REQUIRED BUFFER YARD AREAS AND MATERIALS AND REQUIRED SCREENING MATERIALS. SAID AREAS MUST BE MAINTAINED SO AS TO PRESENT A HEALTHY, NEAT AND ORDERLY APPEARANCE AT ALL TIMES AND SHALL BE KEPT FREE OF REFUSE AND DEBRIS. MAINTENANCE WILL INCLUDE REPLACEMENT OF ALL DEAD PLANT MATERIAL IF THAT MATERIAL WAS USED TO MEET THE REQUIREMENTS OF THE UDC. ALL SUCH PLANTS SHALL BE REPLACED WITHIN SIX (6) MONTHS OF NOTIFICATION, OR BY THE NEXT PLANTING SEASON, WHICHEVER COMES FIRST. A PROPERTY/HOMEOWNERS ASSOCIATION MAY ASSUME RESPONSIBILITY FOR MAINTENANCE OF COMMON AREAS.
- 4. THIS LANDSCAPE PLAN HAS BEEN PREPARED AND CERTIFIED BY A LANDSCAPE ARCHITECT TO MEET ALL REQUIREMENTS OF THE CITY OF GEORGETOWN UNIFIED DEVELOPMENT CODE.
- 5. ALL PLANT SELECTIONS HAVE BEEN CHOSEN FROM THE CITY OF GEORGETOWN PREFERRED PLANT LIST.
- 6. NO MORE THAN 25% OF PLANTINGS HAVE BEEN SELECTED FROM ANY ONE SPECIES. (IF PLANTING MORE THAN 5 TREES OR 10 SHRUBS)
- 7. AT LEAST 50% OF THE REQUIRED PLANT MATERIALS ARE LOW WATER USERS AS IDENTIFIED ON THE PREFERRED PLANT LIST.



TREE LEGEND


HERITAGE TREE



SAVED TREE

GENERAL LANDSCAPE NOTES:

- 1. A 3 FOOT CLEAR SPACE SHALL BE MAINTAINED AROUND THE CIRCUMFERENCE OF THE FIRE HYDRANTS.
- 2. CONTRACTOR TO EXERCISE EXTREME CAUTION WHEN WORKING AROUND HERITAGE TREES AND THAT ANY TRIMMING OF LIMBS OF DESIGNATED HERITAGE TREES MUST REQUIRE AN ARBORIST AND LANDSCAPE ARCHITECT ON-SITE PRIOR TO ANY WORK PERFORMED.

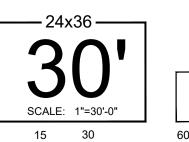

60 90



SUBMISSIONS | REVISIONS::

02.11.2019 SUP REVIEW

NOT FOR CONSTRUCTION

The Texas Board of Architectural Examiners, P.O. Box 12337, Austin, Texas 78701-2337 or 333 Guadalupe, Suite 2-330, Austin, Texas 78701-3942, (512)305-9000, has jurisdiction over individuals licensed under the Landscape Architects Registration Law, Texas Civil Statutes, Article 249c.



round rock, texas 78664 studio1619.com



This document is an instrument of service protected by the copyright law of the United States of America, 17 U.S.C. § 102, and shall not be copied or reproduced without the express written consent of studio | 16:19, LLC

civil engineer :: Steger Bizzell

1978 S. Austin Avenue Georgetown, Tx 78626 p:: 512.930.9412 www.stegerbizzell.com Texas Registered Engineering Firm F-181

architect ::

mustard design architects
209 s llano street, suite b
fredericksburg, texas 78624
p:: 830.997.7024
f:: 830.990.8424
www.mustarddesign.net

RIVERBLUFF 1 ULTI-FAMILY SCENIC DRIVE, GEORGETOWN, TEXAS 78626

sheet information ::

project #:: 18.456
date :: 02.11.2019
designed :: rk
drawn :: rk
checked :: jw
approved :: bab

LA1.00

OVERALL PLAN / TREE PROTECTION PLAN